


 ELECTRICAL PROVIDED BY OTHERS

 ELECTRICAL PROVIDED BY NOISE BARRIERS

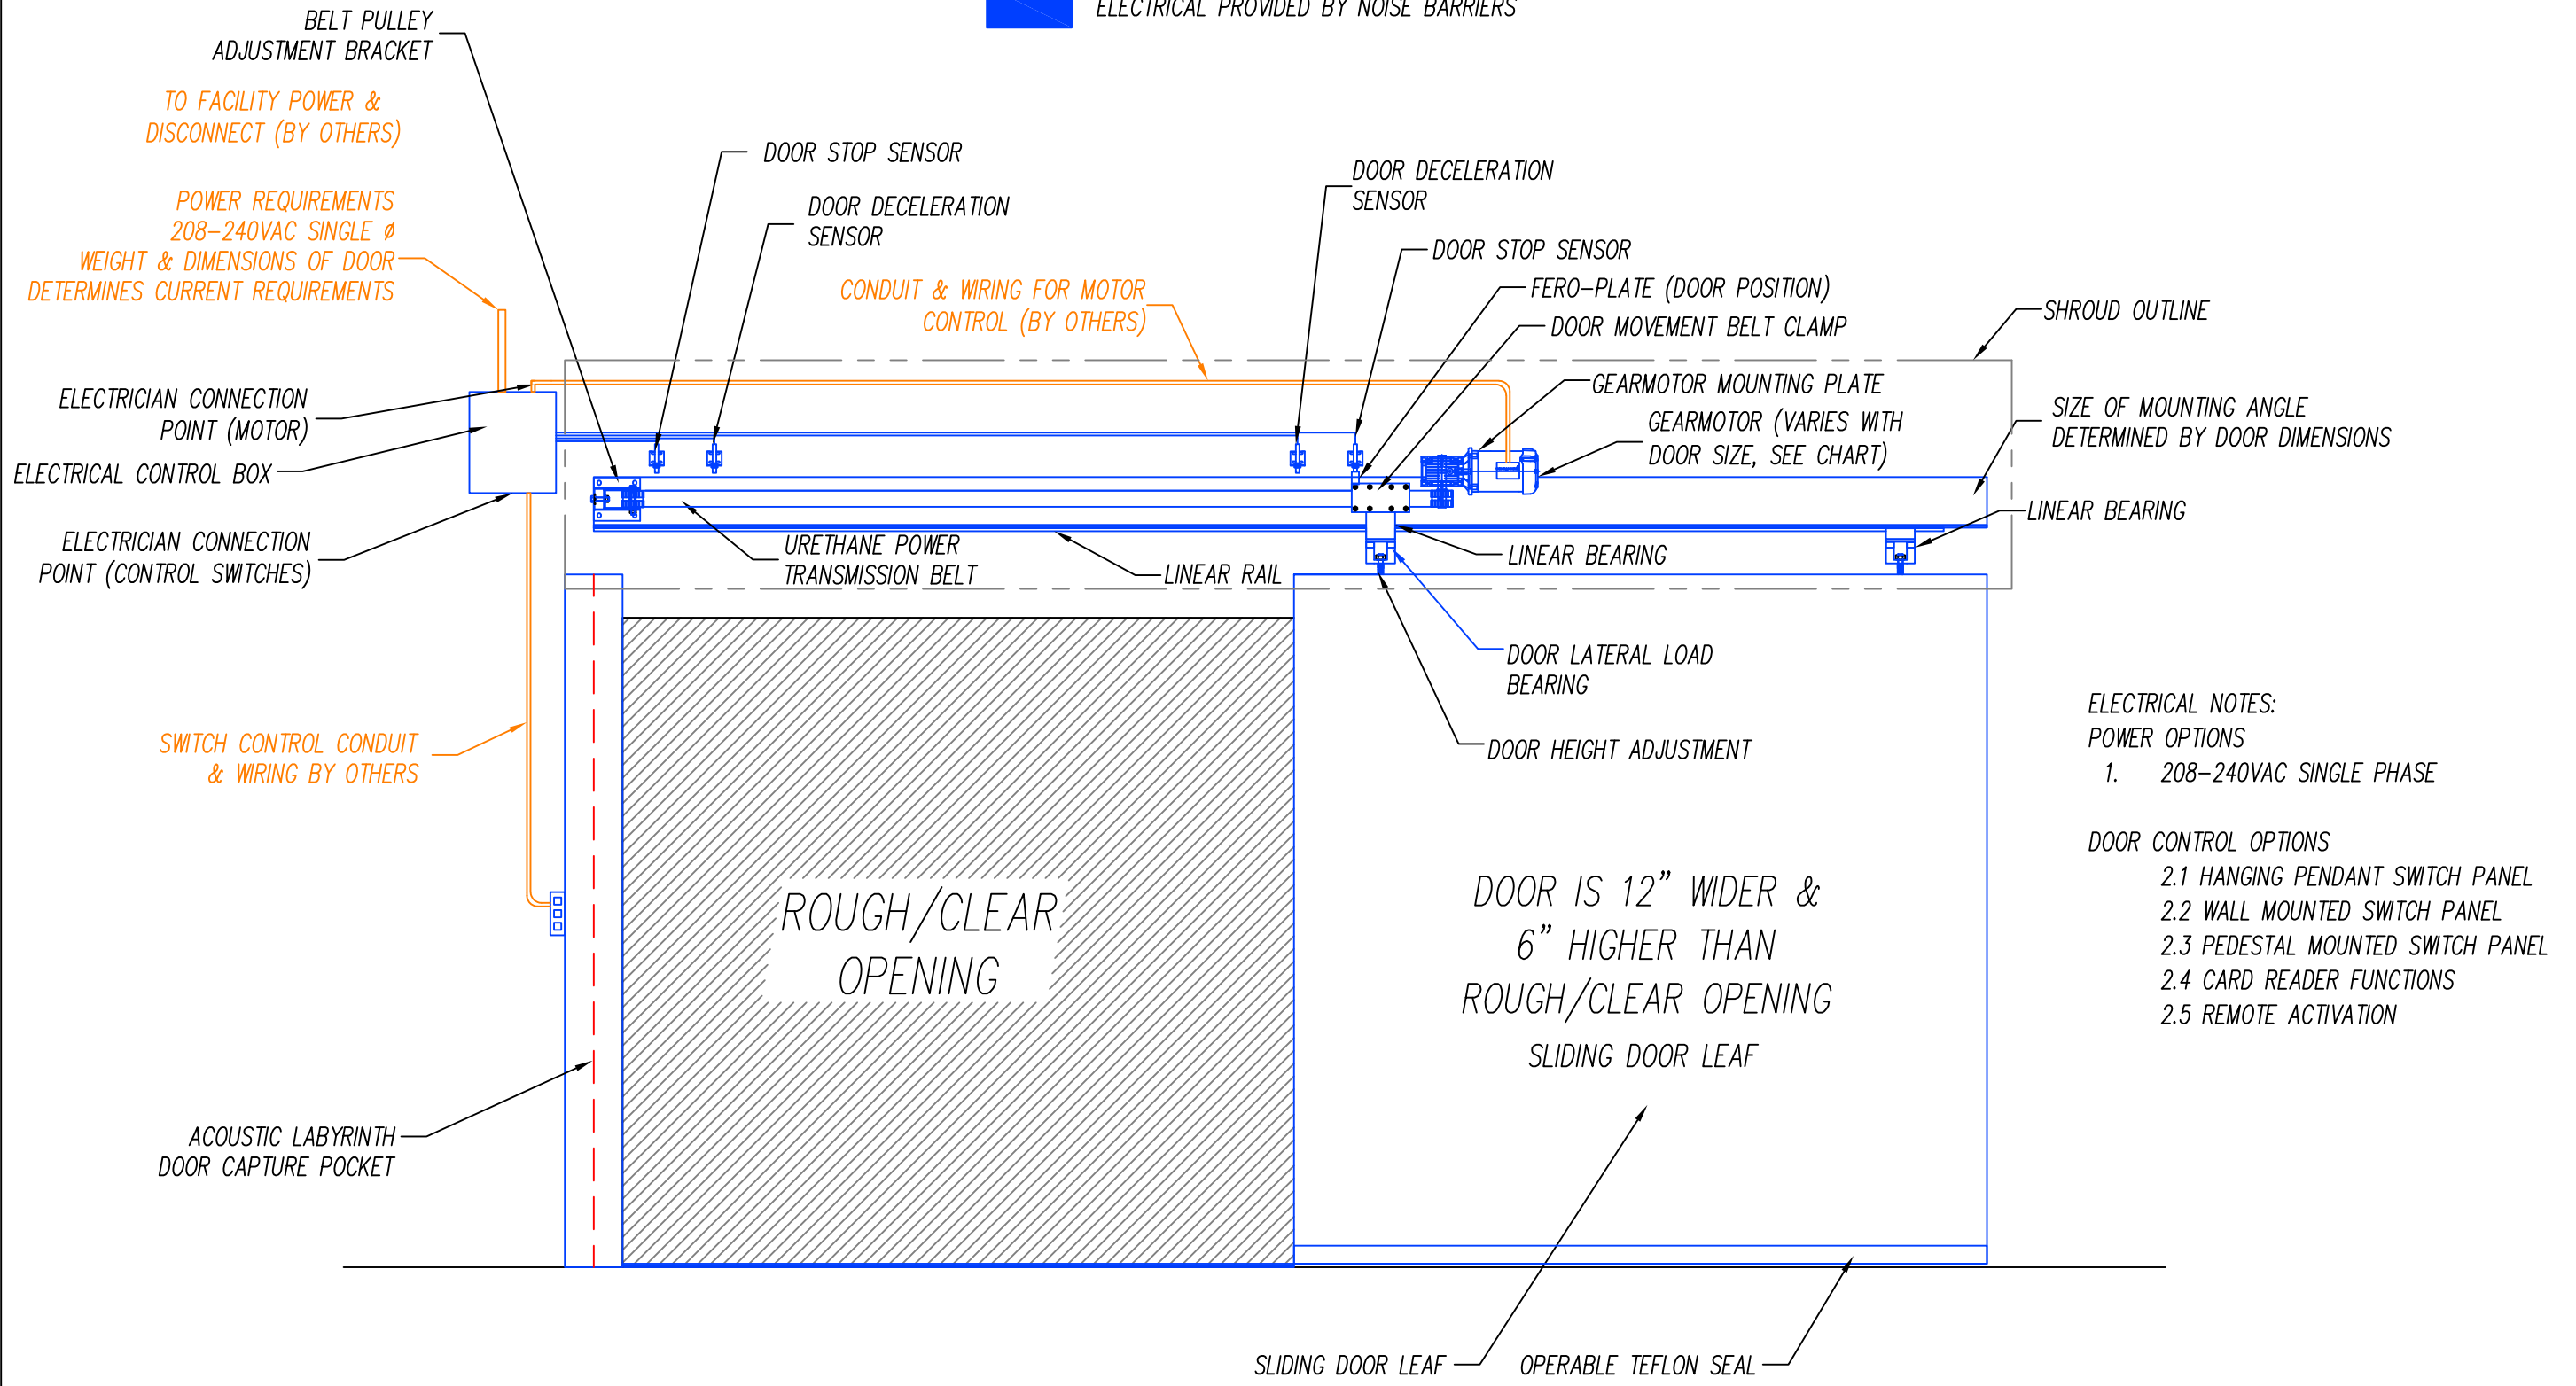

TO FACILITY POWER & DISCONNECT (BY OTHERS)

POWER REQUIREMENTS
208-240VAC SINGLE Ø
WEIGHT & DIMENSIONS OF DOOR
DETERMINES CURRENT REQUIREMENTS

CONDUIT & WIRING FOR MOTOR CONTROL (BY OTHERS)

ELECTRICAL NOTES:
POWER OPTIONS
1. 208-240VAC SINGLE PHASE

DOOR CONTROL OPTIONS
2.1 HANGING PENDANT SWITCH PANEL
2.2 WALL MOUNTED SWITCH PANEL
2.3 PEDESTAL MOUNTED SWITCH PANEL
2.4 CARD READER FUNCTIONS
2.5 REMOTE ACTIVATION


DOOR IS 12" WIDER &
6" HIGHER THAN
ROUGH/CLEAR OPENING
SLIDING DOOR LEAF

ELECTRICAL LAYOUT

PROPRIETARY
THIS DESIGN AND DRAWING IS THE EXCLUSIVE PROPERTY OF NOISE BARRIERS, LLC. AND IS SUBMITTED AS CONFIDENTIAL INFORMATION IN CONNECTION WITH YOUR INQUIRY. IT MUST NOT BE USED FOR ANY OTHER PURPOSES, NOR CAN IT BE COPIED OR LOANED WITHOUT WRITTEN PERMISSION. UPON REQUEST IT MUST BE RETURNED IMMEDIATELY.

REVISIONS	DESCRIPTION	DATE	BY
ORIGINAL/INITIAL		10/6/15	MD
REVISION 1		7/18/16	MD

DESCRIPTION LTD-SL QUIET SLIDE MOTOR OPERATED SLIDING DOOR		CUSTOMER	
DRAWN BY MDD	SCALE N.T.S.	PROJECT NO. XXXX	
DATE 9/27/2018	SHEET 2 OF 4		



NOISE BARRIERS
401 AIRPORT DRIVE
NORTH AURORA, IL 60532
Phone: (847) 843-0500
Fax: (847) 843-0501
www.noisebarriers.com